


1. ESTIMATED UNIT WEIGHT 20,000#.
2. ALL CUSTOMER INSTALLED PIPING THAT IS ATTACHED TO SKID CONNECTIONS SHALL BE SELF SUPPORTING.
3. EXACT LOCATION OF NOTED ITEMS ARE TO BE DETERMINED AT FINAL ASSEMBLY.
4. NOTED CONNECTIONS MUST BE VENTED TO A SAFE LOCATION.
5. PIPING CONNECTIONS TO THIS PACKAGE SHALL NOT BE COMPLETED WITH PRE-FABRICATED PIPE SPOOLS. THE MANUFACTURING TOLERANCES OF THE COMPONENTS INVOLVED ARE NOT SUFFICIENT TO ALLOW PRE-FABRICATED PIPE SPOOLS WITHOUT UNACCEPTABLE PIPING STRAINS. QUADNA WILL NOT BE HELD LIABLE FOR RE-WORK TO PRE-FABRICATED COMPONENTS INTENDED TO ATTACH TO THIS PACKAGE.
6. SEE QUADNA DRAWING #300037 FOR ANCHOR BOLT LOCATIONS AND FOUNDATION REQUIREMENTS.
7. SEE QUADNA DRAWING #300037 FOR BASE SKID LIFTING LUG SIZE AND LOCATION. USE LIFTING LUGS ON MAIN SKID ONLY.
8. GUARDS ARE NOT SHOWN FOR CLARITY. GUARDS WILL BE PROVIDED BY QUADNA ON ALL ROTATING SHAFTS, COUPLINGS, SHEAVES AND BELTS.

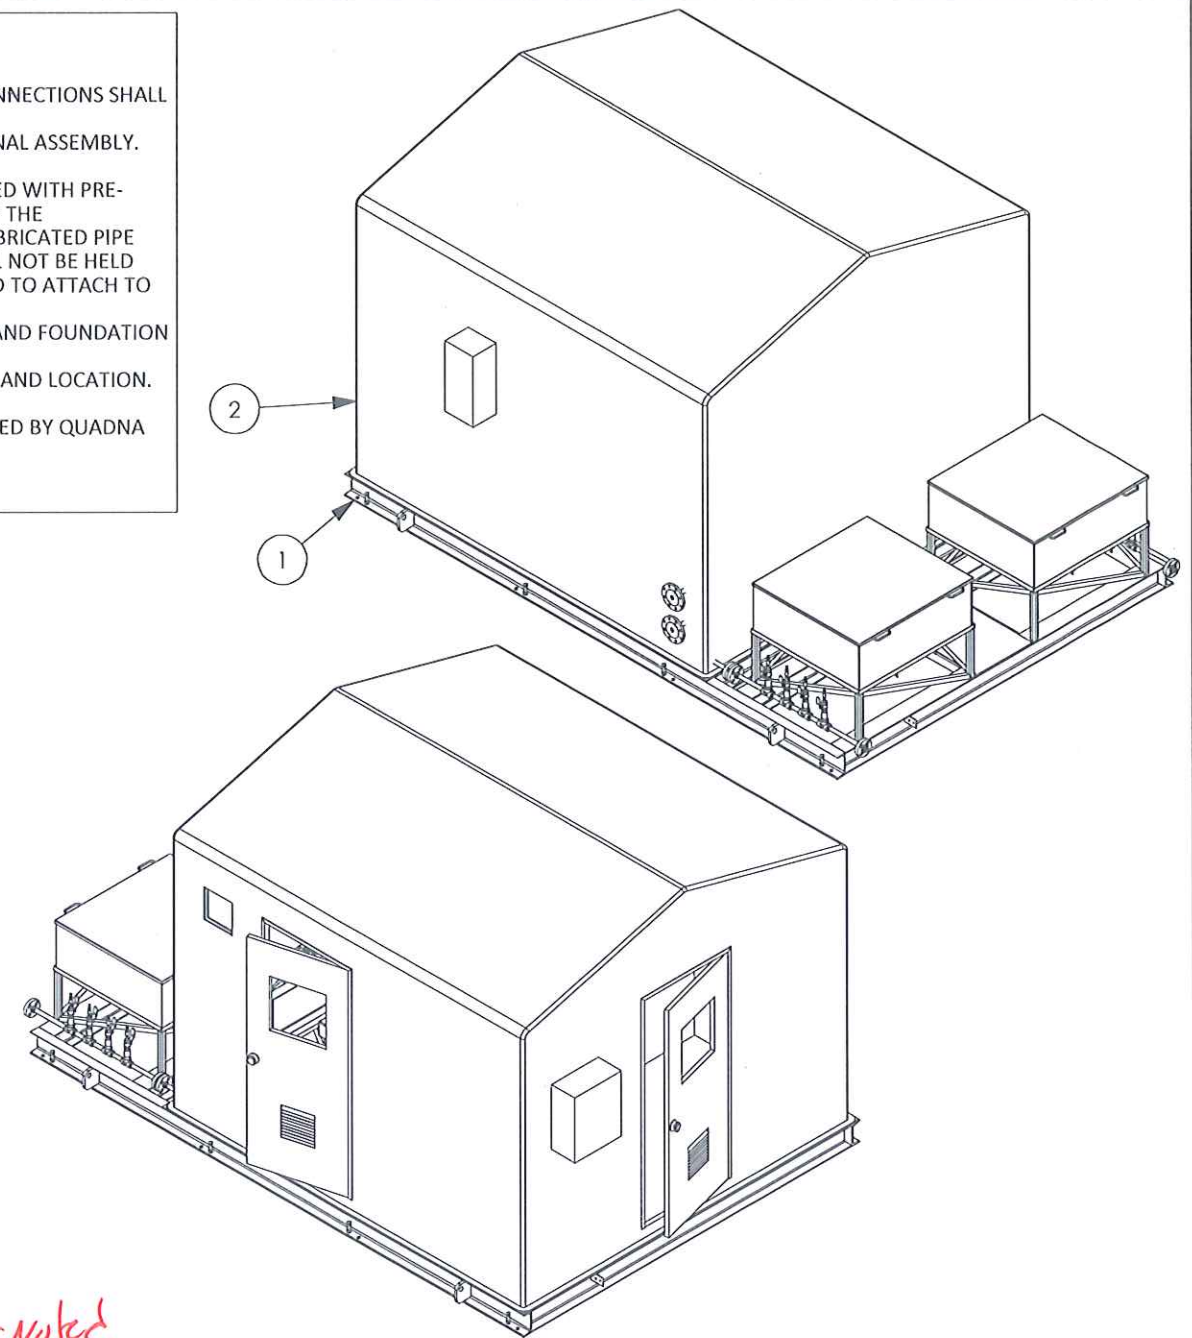

AS-noted


**"CONTROLLED"**

DATE 11-06-13 .....


INITIAL PJA .....

## 2 WELL WATER INJECTION SKID - #5666811


9	1	REGULAR DUTY HEATER, NOT SHOWN
8	1	MCC
7	1	ELEC PANEL
6	1	480V JUNCTION BOX
5	1	HEAT TRACE PANEL
4	2	CHEMICAL PUMP AND STAND, SEE DWG 600032 FOR ENCLOSURE
3	2	CAT PUMP AND STAND
2	1	FIBERGLASS FRAME ENCLOSURE, SEE DWG 600013
1	1	BASE SKID, SEE DWG 300024
<b>ITEM NO.</b>	<b>QTY.</b>	<b>DESCRIPTION</b>
<b>- BILL OF MATERIALS -</b>		


<b>STANDARD TOLERANCE</b> UNLESS OTHERWISE SPECIFIED  FRACTIONAL: FRACTION ±3/8 DECIMAL: 1 PLACE ±.1 2 PLACE ±.06 3 PLACE ±.031 BREAK ALL SHARP EDGES	<b>CUSTOMER CONNECTIONS TOLERANCE</b> UNLESS OTHERWISE SPECIFIED  FRACTIONAL: FRACTION ±1" DECIMAL: 1 PLACE ±.1 2 PLACE ±.06 3 PLACE ±.031 BREAK ALL SHARP EDGES	THIS DRAWING AND INFORMATION DEPICTED HEREIN IS THE PROPERTY OF QIADNA, A DXP COMPANY. COPIES ARE ISSUED IN STRICT CONFIDENCE AND SHALL NOT BE REPRODUCED OR COPIED, OR USED AS THE BASIS FOR THE MANUFACTURE OR SALE OF PRODUCTS WITHOUT PRIOR WRITTEN PERMISSION OF QIADNA, A DXP COMPANY.	<b>REFERENCE DRAWINGS</b> 600030 PUMP ENCLOSURE DETAILS 600028 ENCLOSURE DETAILS 500038 PIPE DETAILS 300037 SKID PACKAGE DETAILS 200047 PIPING & INSTRUMENTATION DIAGRAM DWG. NO. TITLE	<b>REVISIONS</b> <table border="1"> <tr><td></td><td></td><td></td><td></td><td></td><td></td></tr> <tr><td></td><td></td><td></td><td></td><td></td><td></td></tr> <tr><td></td><td></td><td></td><td></td><td></td><td></td></tr> <tr><td></td><td></td><td></td><td></td><td></td><td></td></tr> <tr><td></td><td></td><td></td><td></td><td></td><td></td></tr> <tr><td>0</td><td>ISSUE FOR CONSTRUCTION</td><td>IR</td><td>10/15</td><td></td><td></td></tr> <tr> <td>REV.</td> <td>DESCRIPTION</td> <td>BY</td> <td>DATE</td> <td>CHK</td> <td>DATE</td> </tr> </table>																															0	ISSUE FOR CONSTRUCTION	IR	10/15			REV.	DESCRIPTION	BY	DATE	CHK	DATE	DRAWN BY: I, RICH DATE DRAWN: 9/18/2013 CHECKED BY: DATE CHECKED: <div style="text-align: center;">  </div> <div style="text-align: center;"> <b>2 WELL WATER INJECTION SKID GENERAL ARRANGEMENT</b> </div> SCALE: 1:34 PROJECT NO: 5666811 DWG NO: 100048 REV. 0
0	ISSUE FOR CONSTRUCTION	IR	10/15																																												
REV.	DESCRIPTION	BY	DATE	CHK	DATE																																										



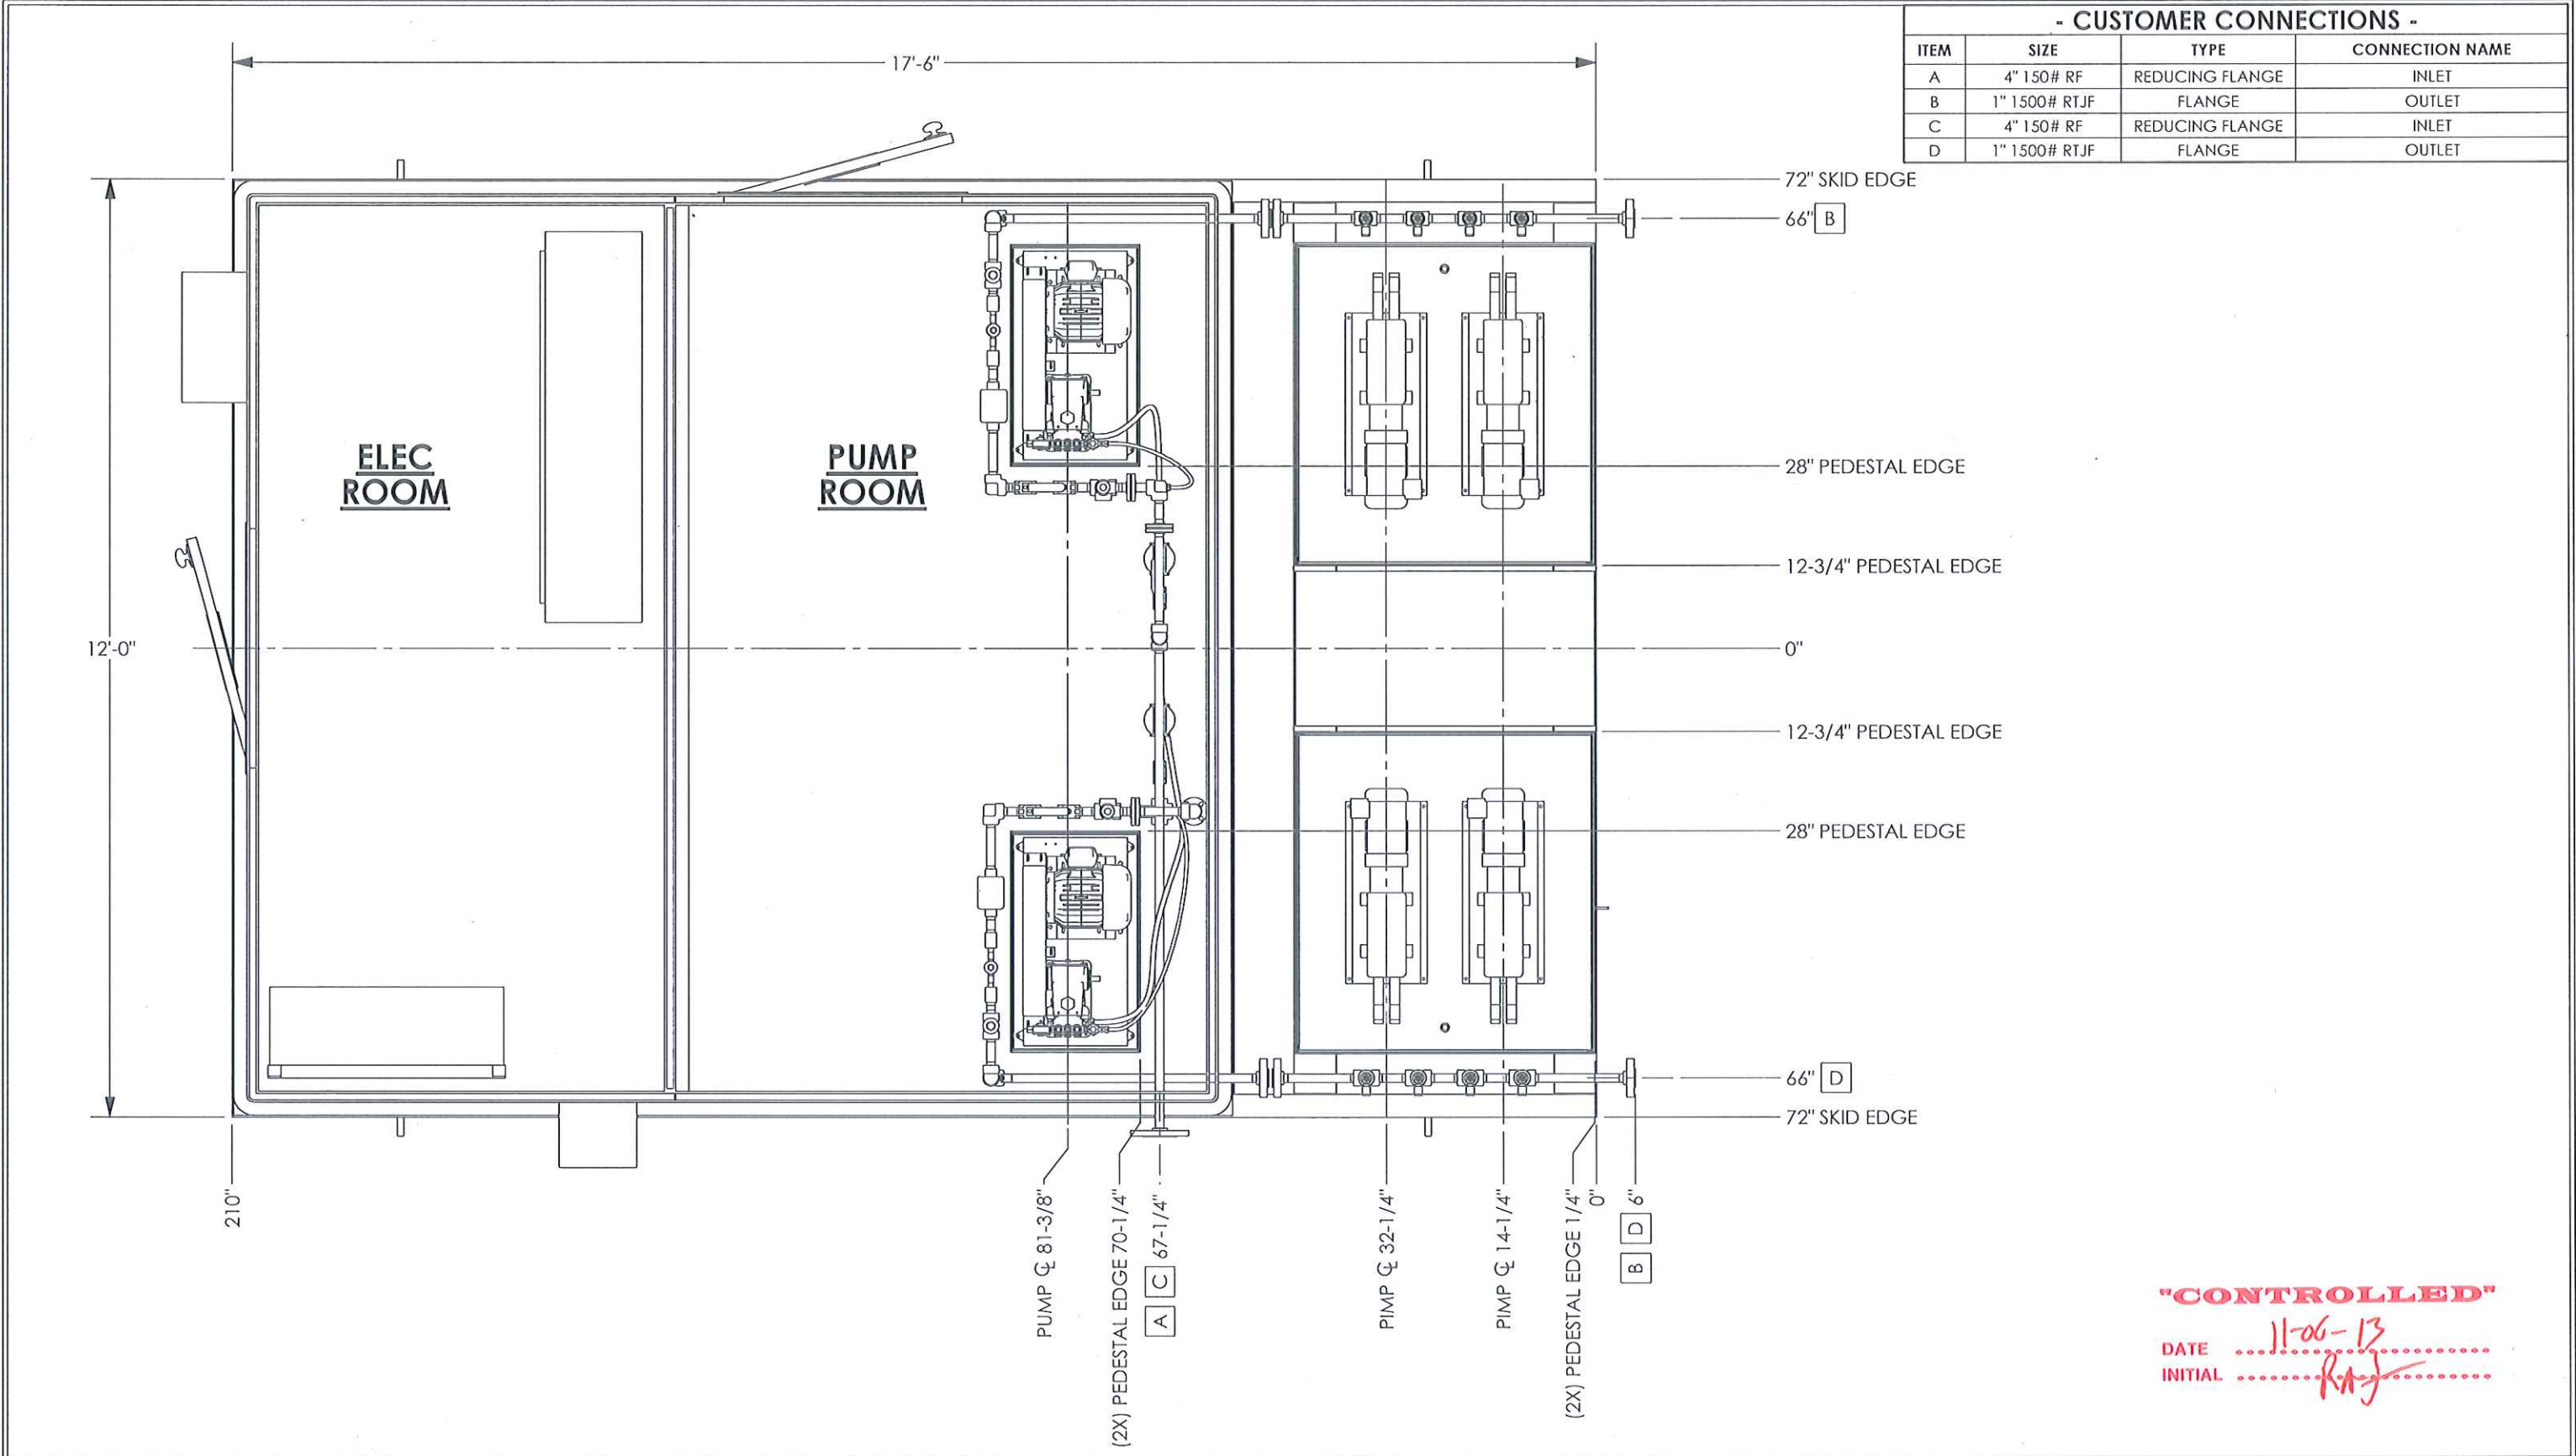

STANDARD TOLERANCE UNLESS OTHERWISE SPECIFIED		CUSTOMER CONNECTIONS TOLERANCE UNLESS OTHERWISE SPECIFIED		THIS DRAWING AND INFORMATION DEPICTED HEREIN IS THE PROPERTY OF QUADNA, A DXP COMPANY. COPIES ARE ISSUED IN STRICT CONFIDENCE AND SHALL NOT BE REPRODUCED OR COPIED, OR USED AS THE BASIS FOR THE MANUFACTURE OR SALE OF PRODUCTS WITHOUT PRIOR WRITTEN PERMISSION OF QUADNA, A DXP COMPANY.		REFERENCE DRAWINGS		REVISIONS		DRAWN BY: I. RICH		CHECKED BY:		DATE DRAWN: 9/18/2013		DATE CHECKED:		SCALE: 1:24		PROJECT NO: 5666811		DWG NO: 100048		REV. 0	
FRACTIONAL: 1/8"	FRACTIONAL: 1/8"	FRACTIONAL: 1/8"	FRACTIONAL: 1/8"			600030	PUMP ENCLOSURE DETAILS																		
DECIMAL: ±.1	DECIMAL: ±.1	DECIMAL: ±.1	DECIMAL: ±.1			600028	ENCLOSURE DETAILS																		
1 PLACE ±.06	1 PLACE ±.06	1 PLACE ±.06	1 PLACE ±.06			500038	PIPE DETAILS																		
3 PLACE ±.031	3 PLACE ±.031	3 PLACE ±.031	3 PLACE ±.031			300037	SKID PACKAGE DETAILS																		
BREAK ALL SHARP EDGES	BREAK ALL SHARP EDGES	BREAK ALL SHARP EDGES	BREAK ALL SHARP EDGES			200047	PIPING & INSTRUMENTATION DIAGRAM																		
DWG. NO.		TITLE		REV.		DESCRIPTION		BY		DATE		CHK		DATE		APPR		DATE							

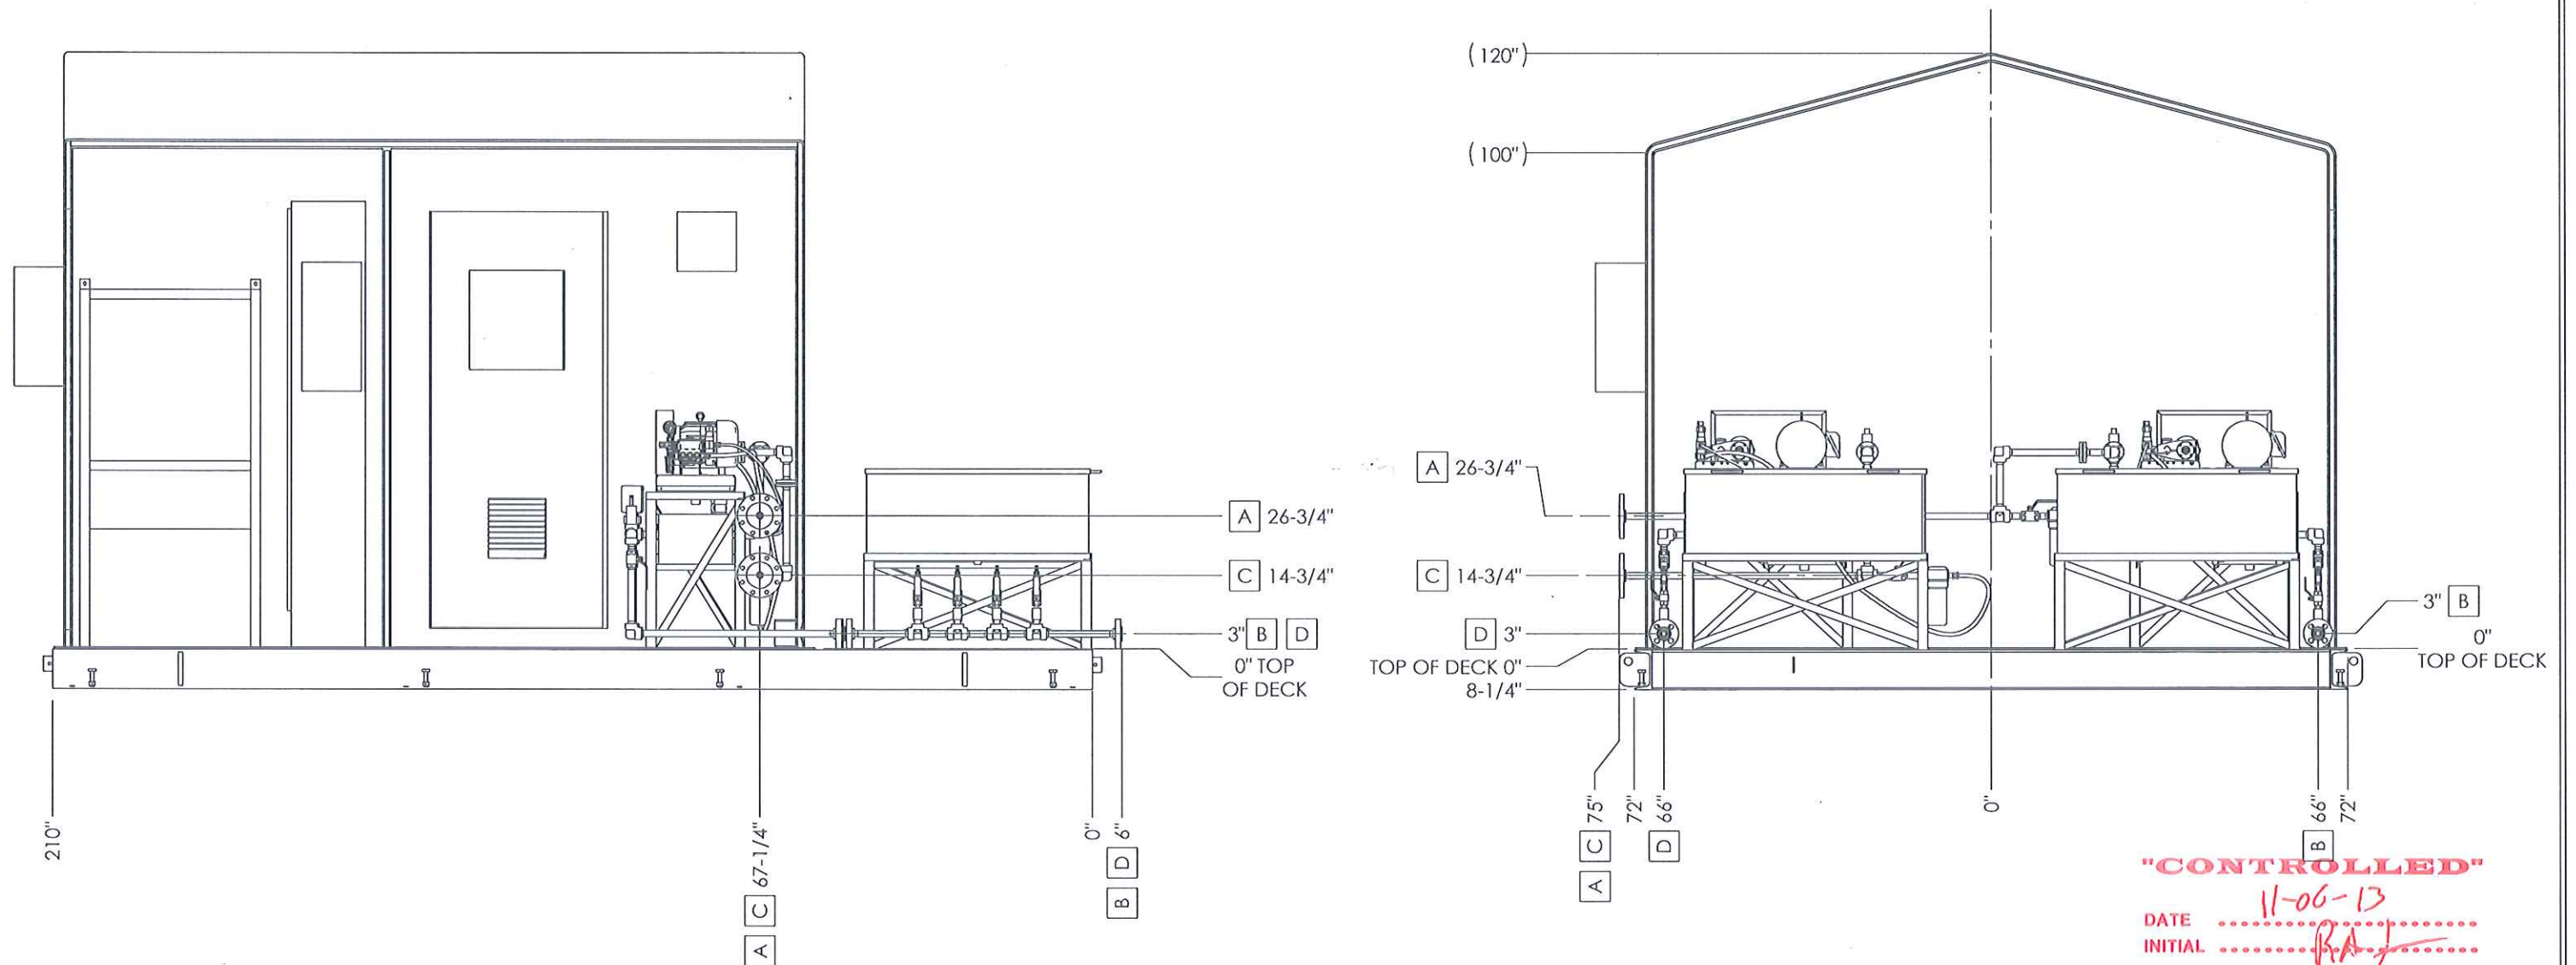

<div>STANDARD TOLERANCE</div> <div>UNLESS OTHERWISE SPECIFIED</div> <div>FRACTIONAL: FRACTION ±3/8</div> <div>DECIMAL: 1 PLACE ±.1</div> <div>2 PLACE ±.06</div> <div>3 PLACE ±.031</div> <div>BREAK ALL SHARP EDGES</div>		<div>CUSTOMER CONNECTIONS TOLERANCE</div> <div>UNLESS OTHERWISE SPECIFIED</div> <div>FRACTIONAL: FRACTION ±1"</div> <div>DECIMAL: 1 PLACE ±.1</div> <div>2 PLACE ±.06</div> <div>3 PLACE ±.031</div> <div>BREAK ALL SHARP EDGES</div>		THIS DRAWING AND INFORMATION DEPICTED HEREIN IS THE PROPERTY OF QIADNA, A DXP COMPANY. COPIES ARE ISSUED IN STRICT CONFIDENCE AND SHALL NOT BE REPRODUCED OR COPIED, OR USED AS THE BASIS FOR THE MANUFACTURE OR SALE OF PRODUCTS WITHOUT PRIOR WRITTEN PERMISSION OF QIADNA, A DXP COMPANY.		<div>REFERENCE DRAWINGS</div> <div>600030 PUMP ENCLOSURE DETAILS</div> <div>600028 ENCLOSURE DETAILS</div> <div>500038 PIPE DETAILS</div> <div>300037 SKID PACKAGE DETAILS</div> <div>200047 PIPING &amp; INSTRUMENTATION DIAGRAM</div> <div>DWG. NO. TITLE</div>		<div>REVISIONS</div> <div>0 ISSUE FOR CONSTRUCTION</div> <div>REV. DESCRIPTION</div>						<div>DRAWN BY: I. RICH</div> <div>DATE DRAWN: 9/18/2013</div>		<div>CHECKED BY:</div> <div>DATE CHECKED:</div>		<div></div>	
2 WELL WATER INJECTION SKID GENERAL ARRANGEMENT																			
SCALE: 1:32		PROJECT NO: 5666811		DWG NO: 100048		REV. 0		SHEET 3 OF 3											